

GENERAL FLOOR PLAN NOTES

- A. DO NOT SCALE DRAWINGS, REFER TO DIMENSIONS SHOWN.
- B. VERIEY ALL EXISTING CONDITIONS AND INFORM ARCHITECT OF ANY DISCREPANCY.
- C. CONTACT ARCHITECT FOR ANY MISSING DIMENSIONS OR INFORMATION. D. UNLESS NOTED OTHERWISE, ALL DIMENSIONS ARE TO FACE OF MASONRY OR
- FACE OF STUD. E. PROVIDE R-19 MIN. INSULATION IN ATTIC SPACES.
- F. PROVIDE R-13 INSULATION AT ALL EXTERIOR WALLS. INSULATE AROUND PLUMBING PIPES.
- G. CAPPENTER TO COORDINATE FRAMING LAYOUT WITH LIGHTING, PLUMBING AND MECHANICAL PLANS AND INFORM ARCHITECT OF ANY DISCREPANCIES. ALL REQUIRED FURNING, SOFTITS AND CEILING JOISTS FOR VOLUME CEILINGS SHALL BE INCLUDED IN BID.
- H, REFER TO REFLECTED CEILING PLANS, BUILDING SECTIONS AND INTERIOR ELEVATIONS FOR VOLUME CEILINGS.
- I. STRUCTURAL FRAMING MAY NOT BE SHOWN ON STRUCTURAL PLANS. ROUGH CARPENTER TO REVIEW ALL ARCHITECTURAL SHEETS FOR CLEAR UNDERSTANDING OF WORK TO BE INCLUDED IN BID.
- J. PROVIDE DRAFT STOPS AS REQUIRED BY CURRENT BUILDING CODE. ENCLOSED SPACES IN STUD WALL, PARTITIONS AND FURRED WALLS SHALL HAVE FIRE STOPS AT TOP AND BOTTOM AND AT MID-POINT IN WALLS MORE THAN 10 FEET HIGH, VERIFY WITH STRUCTURAL PLANS.
- K. CONTRACTOR SHALL ALLOW FOR AND PROVIDE ALL REQUIRED SHIMING SO THAT ALL FINISH FLOOR MATERIALS FINISH AT THE SAME ELEVATION U.N.O.
- L. SEE GENERAL NOTES, SPECIFICATIONS MANUAL, AND STRUCTURAL PLANS FOR ADDITIONAL FRAMING INFORMATION.
- M. VERIFY ALL ROUGH OPENING SIZES FOR WINDOWS AND DOORS WITH MANUFACTURER.
- N. PROVIDE 40 LUMENS / WATT OR GREATER FOR GENERAL LIGHTING IN KITCHENS AND ROOMS WITH WATER CLOSETS.(FLUORESCENT)
- O. PLUMBING FIXTURE HARDWARE SHALL COMPLY AS FOLLOWS: LOW FLOW TOILETS (IS OF FLUSH), SHOWERHEAD (2.5 GPM), AND FAUCETS (2.2 GPM) PER WATER CONSERVATION CODE REQUIREMENTS.
- WATER CONSTRUCTION SHALL NOT RESTRICT A FIVE-FOOT CLEAR AND UNOBSTRUCTED ACCESS TO ANY WATER OR POWER DISTRIBUTION FACILITIES POWER POLES, PULL-BOXES TERMS-FOATHERS, VAULTS, PUMPS, VALVES, METERS, APPURTEMANCES, ETC.) OR TO THE LOCATION OF THE HOOK-UP. THE CONSTRUCTION SHALL NOT BE WITHIN TER FEET OF ANY POWER LINES WHETHER OR NOT THE LINES ARE LOCATED ON THE PROPERTY, FAILURE TO COMPLY MAY CAUSE CONSTRUCTIONS DELAYS AND/OR ADDITIONAL EXPENSES.
- O. AN APPROVED SEISMIC GAS SHUTOFF VALVE WILL BE INSTALLED ON THE FUEL GAS LINE ON THE DOWN STREAM SIDE OF THE UTILITY METER AND BE RIGIDLY CONNECTED TO THE EXTERIOR OF THE BUILDING OR STRUCTURE CONTAINING THE FUEL GAS PIPING.
- R. PLUMBING FIXTURES ARE REQUIRED TO BE CONNECTED TO A SANITARY SEWER OR TO AN APPROVED SEWAGE DISPOSAL SYSTEM.

 S. KITCHEN SINKS, LAVATORIES, BATHTUBS, SHOWERS BIDETS, LAUNDRY TUBS AND WASHING MACHINE OUTLETS SHALL BE PROVIDED WITH HOT AND COLD WATER AND CONNECTED TO AN APPROVED WATER SUPPLY.
- f. BATHTUB AND SHOWER FLOORS, WALLS ABOVE BATHTUBS WIT HA SHOWERHEAD, AND SHOWER COMPARTMENTS SHALL BE FINISHED WITH A NON-ABSORENT SURFACE, SUCH WALL SURFACES SHALL EXTEND TO A HEIGHT OF NOT LESS THAN 6 FEET ABOVE THE FLOOR.
- U. PROVED ULTRA LOW FLUSH WATER CLOSETS FOR ALL NEW CONSTRUCTION. EXISTING SHOWER HEADS AND TOILETS MUST BE ADAPTED FOR LOW WATER
- W. SMOKE DETECTORS SHALL BE PROVIDED FOR ALL DWELLING UNITS INTENDED FOR HUMAN OCCUPANCY, UPON THE OWNER'S APPLICATION FOR A PERMIT FOR ALTERATIONS, REPAIRS, OR ADDITIONS, EXCEEDING ONE THOUSAND DOLLARS.
- ALTERATIONS, REPAIRS, OR ADDITIONS, EXCEEDING ONE THOUSAND DOLLARS.

 X. WHERE A PERMIT IS REQUIRED FOR ALTERATIONS, REPAIRS OR ADDITIONS

 EXCEEDING ONE THOUSAND DOLLARS, EXISTING DWELLINGS OR S. EEPING UNITS

 THAT HAVE ATTACHED GARAGES OF PIELE-BURNING APPLIANCES SHALL BE

 PROVIDED WITH A CARBON MONOXIDE ALARM IN ACCORDANCE WITH SECTION

 R3ISL, CARBON MONOXIDE ALARMS SHALL ONLY, BE REQUIRED IN THE SPECIFIC

 DWELLING UNIT OR SLEEPING UNIT FOR WHICH THE PERMIT WAS OBTAINED.

KEY NOTES

- 1 PROVIDE I HR FIRE-RATED WALL WHERE GARAGE MEETS LIVING SPACE.
- 2 ALL WOOD PANELING ON EXISTING WALLS TO BE REMOVED AND REPLACED WITH DRYWALL WHERE APPLICABLE.
- 3 ALL ALUMINUM SIDING TO BE REMOVED AND REPLACED WITH STUCCO AT BUILDING EXTERIOR, SEE EXTERIOR ELEVATIONS.
- 5 SMOKE ALARM, INTERCONNECTED AND HARDWIRED WITH BATTERY BACK-UP
- 6 CARBON MONOXIDE ALARM, INTERCONNECTED AND HARDWIRED WITH BATTERY BACK-UP

WALL TYPE LEGEND

SEE A-7.0 SERIES FOR BUILDING SECTIONS AND DETAIL CALL-OUTS. SEE A-9.0 SERIES FOR DETAILS.

EXISTING WALL TO REMAIN

==== EXISTING WALL TO BE DEMOLISHED NEW 2x4 NON-RATED WALL



F: 323/275-114) INFO SLETTERFOUR.COM

PROJECT

ARCHITECT

LINSCOTT 1673 NEW YORK DR. (MAIN)

1917 SINALOA AVE. (2ND UNIT) ALTADENA, CA 91001 APN 5847-028-026 APN 5847-028-024

OWNER

LINSCOTT 110 S. GREENWOOD AVE. PASADENA, CA 91107

REVISIONS

ISSUE	DESCRIPTION	DATE
\triangle	_	_

LAUREN ADAMS, AIA 8513 WASHINTON BL CULVER CITY, CA 90232 AUREN@LETTERFOUR.COM

DISCLAIMER

These plans and incorporated designs embodied thereon are the property of LETTER FOUR, LLC. The use of these plans are restricted to the original site for which they were prepared. Publication and reproduction by any method, in whole or in part, is prohibited. Title to the plans and designs remain with LETTER FOUR, LLC. Visual contact with them constitutes prima facie of acceptance of these restrictions.

PROJECT NAME LINSCOTT

DATE 06.02.14

SCALE

1/4" = 1'-0" DRAWN

LA/MH


1328.00

DRAWING NAME DEMO MAIN FLOOR PLAN

A-4.1

DEMO MAIN FLOOR PLAN 01

SCALE: 1/4"=1'-0"

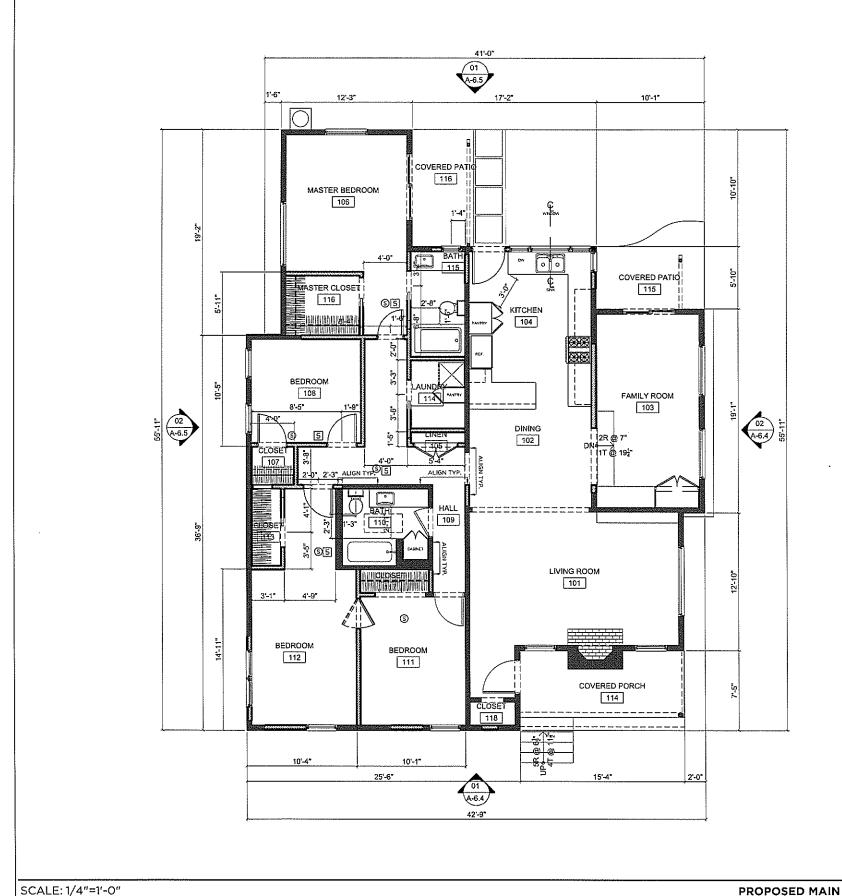

GENERAL FLOOR PLAN NOTES

- A, DO NOT SCALE DRAWINGS, REFER TO DIMENSIONS SHOWN.
- VERIFY ALL EXISTING CONDITIONS AND INFORM ARCHITECT OF ANY DISCREPANCY.
- C. CONTACT ARCHITECT FOR ANY MISSING DIMENSIONS OR INFORMATION.
- D. UNLESS NOTED OTHERWISE, ALL DIMENSIONS ARE TO FACE OF MASONRY OR FACE OF STUD.
- E. PROVIDE R-19 MIN. INSULATION IN ATTIC SPACES.
- P. PROVIDE R-13 INSULATION AT ALL EXTERIOR WALLS. INSULATE AROUND PLUMBING PIPES.
- G. CARPENTER TO COORDINATE FRAMING LAYOUT WITH LIGHTING, PLUMBING AND MECHANICAL PLANS AND INFORM ARCHITECT OF ANY DISCREPANCIES. ALL REQUIRED FURRING, SOFFITS AND CEILING JOISTS FOR VOLUME CEILINGS SHALL BE INCLUDED IN BID.
- REFER TO REFLECTED CEILING PLANS, BUILDING SECTIONS AND INTERIOR ELEVATIONS FOR VOLUME CEILINGS.
- STRUCTURAL FRAMING MAY NOT BE SHOWN ON STRUCTURAL PLANS. ROUGH CARPENTER TO REVIEW ALL ARCHITECTURAL SHEETS FOR CLEAR UNDERSTANDING OF WORK TO BE INCLUDED IN BID.
- J. PROVIDE DRAFT STOPS AS REQUIRED BY CURRENT BUILDING CODE. ENCLOSED SPACES IN STUD WALL, PARTITIONS AND FURRED WALLS SHALL HAVE FIRE STOPS AT TOP AND BOTTOM AND AT MID-POINT IN WALLS MORE THAN 10 FEET HIGH, VERIEY WITH STRUCTURAL PLANS.
- K. CONTRACTOR SHALL ALLOW FOR AND PROVIDE ALL REQUIRED SHIMING SO THAT ALL FINISH FLOOR MATERIALS FINISH AT THE SAME ELEVATION U.N.O.
- L. SEE GENERAL NOTES. SPECIFICATIONS MANUAL, AND STRUCTURAL PLANS FOR ADDITIONAL FRAMING INFORMATION.
- M. VERIFY ALL ROUGH OPENING SIZES FOR WINDOWS AND DOORS WITH MANUFACTURER.
- N. PROVIDE 40 LUMENS / WATT OR GREATER FOR GENERAL LIGHTING IN KITCHENS AND ROOMS WITH WATER CLOSETS.(FLUORESCENT)
- O. PLUMBING FIXTURE HARDWARE SHALL COMPLY AS FOLLOWS: LOW FLOW TOILETS (LE OF FLUSH), SHOWERHEAD (2.5 GPM), AND FAUCETS (2.2 GPM) PER WATER CONSERVATION CODE REQUIREMENTS.
- P. THE CONSTRUCTION SHALL NOT RESTRICT A FIVE-FOOT CLEAR AND UNDSTRUCTED ACCESS TO ANY WATER OR POWER DISTRIBUTION FACILITIES POWER POLES, PULL-BOXES TRANSFORMERS, VAULTS, PUMPS, VALVES, METERS, APPURTENANCES, ETC.) OR TO THE LOCATION OF THE HOCK-UP, THE CONSTRUCTION SHALL NOT BE WITHIN TEN FEET OF ANY POWER LINES WHETHER OR NOT THE LINES ARE LOCATED ON THE PROPERTY, FAILURE TO COMPLY MAY CAUSE CONSTRUCTIONS DELAYS AND/OR ADDITIONAL EXPENSES.
- O. AN APPROVED SEISMIC GAS SHUTOFF VALVE WILL BE INSTALLED ON THE FUEL GAS LINE ON THE DOWN STREAM SIDE OF THE UTILITY METER AND BE RIGIDLY CONNECTED TO THE EXTERIOR OF THE BUILDING OR STRUCTURE CONTAINING THE FUEL GAS PIPNG.
- REVUEL SAY PIPMS.

 R. PLUMBING FIXTURES ARE REQUIRED TO BE CONNECTED TO A SANITARY SEWER OR TO AN APPROVED SEWAGE DISPOSAL SYSTEM.

 S. KITCHEN SINKS, LAVATORIES, BATH-TUBS, SHOWERS BIDETS, LAUNDRY TUBS AND WASHING MACHINE OUTLETS SHALL BE PROVIDED WITH HOT AND COLD WATER AND CONNECTED TO AN APPROVED WATER SUPPLY.
- T. BATHTUB AND SHOWER FLOORS, WALLS ABOVE BATHTUBS WIT HA SHOWERHEAD, AND SHOWER COMPARTMENTS SHALL BE FINISHED WITH A NON-ABSORBENT SURFACE. SUCH WALL SURFACES SHALL EXTEND TO A HEIGHT OF NOT LESS THAN 6 FEET ABOVE THE FLOOR.
- U. PROVED ULTRA LOW FLUSH WATER CLOSETS FOR ALL NEW CONSTRUCTION. EXISTING SHOWER HEADS AND TOILETS MUST BE ADAPTED FOR LOW WATER
- W. SMOKE DETECTORS SHALL BE PROVIDED FOR ALL DWELLING UNITS INTENDED FOR HUMAN OCCUPANCY, UPON THE OWNER'S APPLICATION FOR A PERMIT FOR ALTERATIONS, REPAIRS, OR ADDITIONS, EXCEEDING ONE THO MORSHOLL ARS.
- ALTERATIONS, REPAIRS, OR ADDITIONS, EXCEEDING DUE THOUSAND DOLLARS.

 WHERE A PERMIT IS REQUIRED FOR ALTERATIONS, REPAIRS OR ADDITIONS

 EXCEEDING ONE THOUSAND DOLLARS, EXISTING DWELLINGS OR S. EEPING UNITS

 THAT HAVE ATTACHED GARAGES OR FUEL-BURNING APPLIANCES SHALL BE

 PROVIDED WITH A CARBON MONOXIDE ALARM IN ACCORDANCE WITH SECTION

 R3IS.1 CARBON MONOXIDE ALARMS SHALL ONLY DE REQUIRED IN THE SPECIFIC

 DWELLING UNIT OR SLEEPING UNIT FOR WHICH THE PERMIT WAS OBTAINED.

DISCLAIMER

ARCHITECT

BS13 WASHINGTON BLVD. CULVER CITY CA 90232

LINSCOTT

1673 NEW YORK DR. (MAIN)

ALTADENA, CA 91001

APN 5847-028-026

110 S. GREENWOOD AVE.

PASADENA, CA 91107

APN 5847-028-024

1917 SINALOA AVE. (2ND UNIT)

PROJECT

OWNER

LINSCOTT

REVISIONS

ISSUE DESCRIPTION

LAUREN ADAMS, AIA

CULVER CITY, CA 90232

AUREN@LETTERFOUR.COM

F: 323/275-1141 INFO LETTERFOUR.COM

DATE

- 1 PROVIDE 1 HR FIRE-RATED WALL WHERE GARAGE MEETS LIVING SPACE.
- 2 ALL WOOD PANELING ON EXISTING WALLS TO BE REMOVED AND REPLACED WITH DRYWALL WHERE APPLICABLE.
- 3 ALL ALUMINUM SIDING TO BE REMOVED AND REPLACED WITH STUCCO AT BUILDING EXTERIOR, SEE EXTERIOR ELEVATIONS.

KEY NOTES

- SMOKE ALARM, INTERCONNECTED AND HARDWIRED WITH
- 6 CARBON MONOXIDE ALARM, INTERCONNECTED AND HARDWIRED WITH BATTERY BACK-UP

These plans and incorporated designs embodied thereon are the property of LETTER FOUR, LLC. The use of these plans are restricted to the original site for which they were prepared.
Publication and reproduction by any method, in whole or in part, is prohibited. Title to the plans and designs remain with LETTER FOUR, LLC. Visual contact with them constitutes prima facie of acceptance of these restrictions.

WALL TYPE LEGEND

SEE A-7.0 SERIES FOR BUILDING SECTIONS AND DETAIL CALL-OUTS. SEE A-9.0 SERIES FOR DETAILS.

EXISTING WALL TO REMAIN NEW 2x4 NON-RATED WALL

==== = EXISTING WALL TO BE DEMOLISHED

PROJECT NAME LINSCOTT

DATE 06.02.14

> SCALE 1/4" = 1'-0"

DRAWN LA/MH


JOB# 1328.00


DRAWING NAME

PROPOSED MAIN FLOOR PLAN

A-4.2

PROPOSED MAIN FLOOR PLAN O1

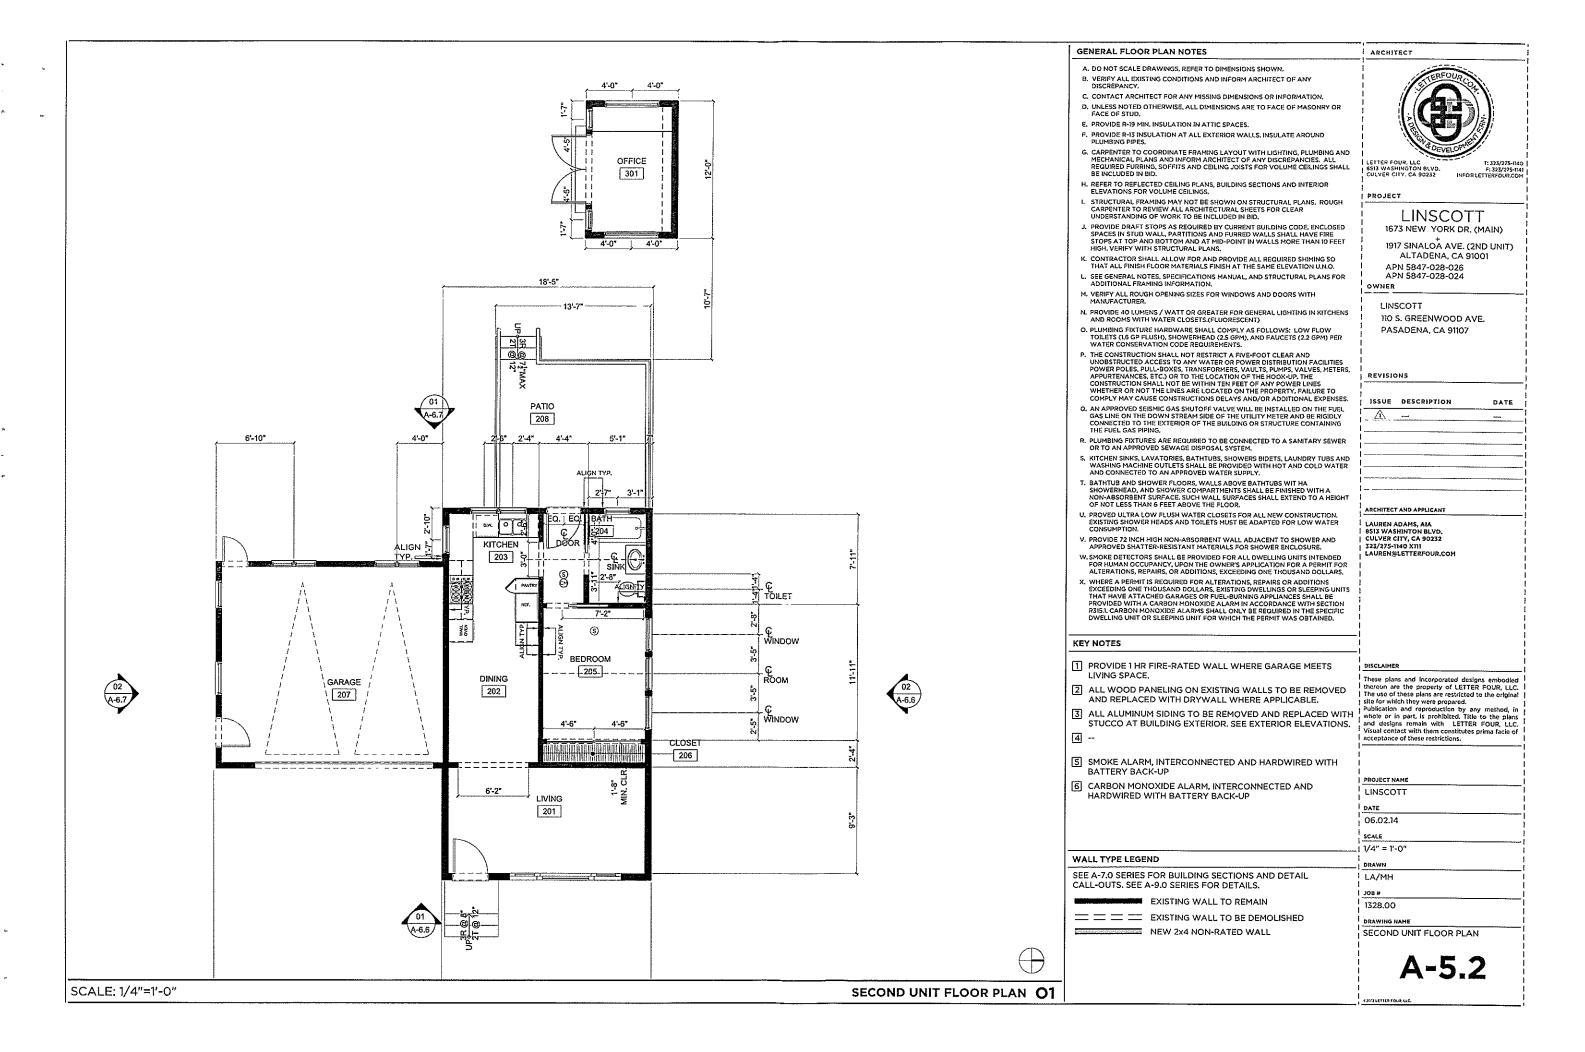


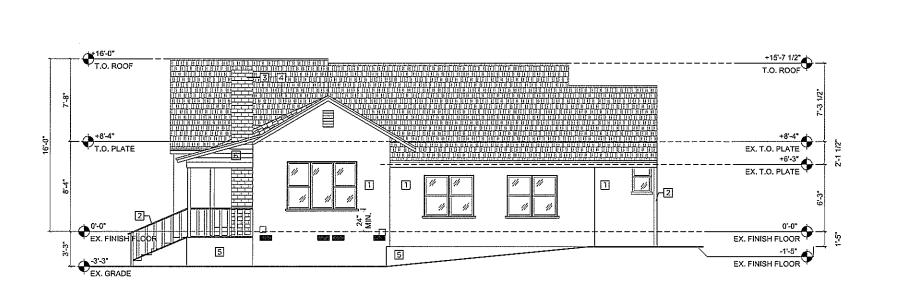


SCALE: 1/4"=1'-0" PROPOSED MAIN WEST ELEVATION 02 +16'-0" T.O. ROOF T.O. ROOF +8'-4" T.O. PLATE +8'-4" EX. T.O. PLATE +6'-3" EX. T.O. PLATE 1 24" MIN 0'-0"


EX. FINISH FLOOR EX. FINISH FLOOR 5000 HO -3'-3" EX. GRADE EX. GRADE SCALE: 1/4"=1'-0" PROPOSED MAIN NORTH ELEVATION O1

NOTES TO SHEET	ARCHITECT
1 STUCCO 2 PAINT GRADE WOOD 3 BRICK 4 CLASS "A" ASPHALT ROOFING 5 CONCRETE SLAB/STEM WALL 6 WOOD SIDING 7 CEMENT FIBER BOARD 8 EXISTING ALUMINUM SIDING TO BE REMOVED 9	LETTER FOUR. ALC 1: 323/275-III. SS13 WASHINGTON BLVD. P: 323/275-III. CULVER CITY GA 90232 INFOGLETIERFOUR.CC
	1673 NEW YORK DR. (MAIN) 1917 SINALOA AVE. (2ND UNIT)
BENERAL ELEVATION NOTES	ALTADENA, CA 91001 APN 5847-028-026
 CONTRACTOR TO VERIFY CONFORMANCE TO CITY AGENCY BUILDING HEIGHTS AND ENVELOPE LIMITS. INFORM ARCHITECT OF ANY DISCREPANCIES. CONTRACTOR TO COORDINATE W/ LANDSCAPE DRAWINGS FOR EXACT LOCATIONS AND ELEVATIONS OF HARDSCAPE. INFORM ARCHITECT OF ANY DISCREPANCIES. PROVIDE CONTINUOUS SHEET METAL WEEP SCREED. LOCATE WEEP SCREED AT LOWEST POSSIBLE POINT OF CONCRETE FOOTING AND SILL PLATE. COLOR COAT FACE OF CONCRETE BELOW WEEP SCREED TO A POINT NOT LESS THAN 4" BELOW FINISH GRADE WHERE WALKS, STEPS, PATIOS, OR OTHER FINISH SURFACES DO NOT OCCUR. U. L. APPROVED SPARK ARRESTORS W/ METAL SHROUD AT TOPS OF ALL FIREPLACE CHIMNEYS. USE IN ACCORDANCE WITH U.L. APPROVED METALBESTOS #SS11 FLUE SYSTEM BY SELKIRK, ALL CHIMNEYS SHALL TERMINATE NOT LESS THAN 2"-0" ABOVE THE HIGHEST POINT OF ROOF WITH IN 10"-0" OF CHIMNEY. 	LINSCOTT
	DISCLAIMER These plans and incorporated designs embodis thereon are the property of LETTER FOUR, LL The use of these plans are restricted to the origin site for which they were prepared. Publication and reproduction by any method, whole or in part, is prohibited. Title to the pia and designs remain with LETTER FOUR, LL Visual contact with them constitutes prima facile acceptance of these restrictions. PROJECT NAME LINSCOTT DATE O6.02.14 SCALE 1/4" = 1'-0" BRAWN LA/MH JOB # 1328.00 DRAWING NAME PROPOSED EXTERIOR ELEVATIONS
	A-6.4

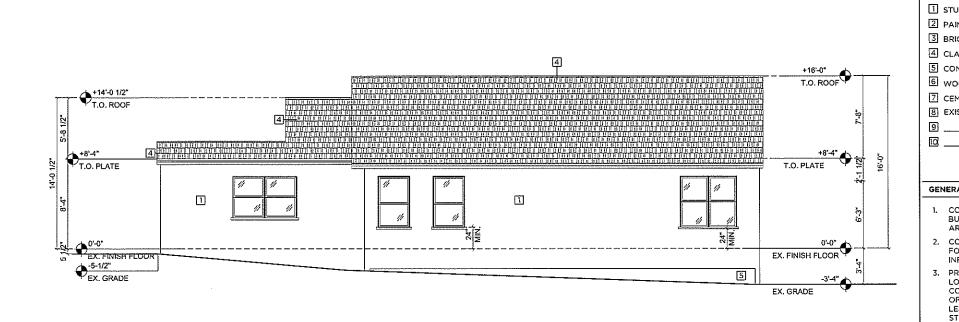


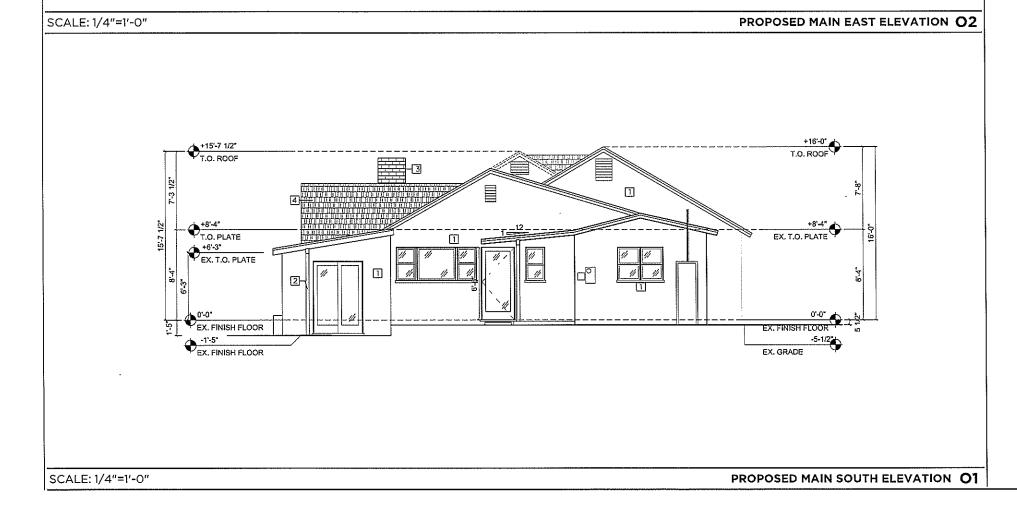

NOTES TO SHEET	ARCHITECT	
NOTES TO SHEET 1 STUCCO 2 PAINT GRADE WOOD 3 BRICK 4 CLASS "A" ASPHALT ROOFING 5 CONCRETE SLAB/STEM WALL 6 WOOD SIDING 7 CEMENT FIBER BOARD 8 EXISTING ALUMINUM SIDING TO BE REMOVED 9 10 10 GENERAL ELEVATION NOTES	LINSCOTT 1673 NEW YORK DR. (MAIN) 1917 SINALOA AVE. (2ND UNIT) ALTADENA, CA 91001 APD 5847-028-026	
CONTRACTOR TO VERIFY CONFORMANCE TO CITY AGENCY BUILDING HEIGHTS AND ENVELOPE LIMITS. INFORM	APN 5847-028-024 owner	
ARCHITECT OF ANY DISCREPANCIES. 2. CONTRACTOR TO COORDINATE W/ LANDSCAPE DRAWINGS FOR EXACT LOCATIONS AND ELEVATIONS OF HARDSCAPE. INFORM ARCHITECT OF ANY DISCREPANCIES.	LINSCOTT 110 S. GREENWOOD AVE. PASADENA, CA 91107	
3. PROVIDE CONTINUOUS SHEET METAL WEEP SCREED. LOCATE WEEP SCREED AT LOWEST POSSIBLE POINT OF CONCRETE FOOTING AND SILL, PLATE. COLOR COAT FACE OF CONCRETE BELOW WEEP SCREED TO A POINT NOT LESS THAN 4" BELOW FINISH GRADE WHERE WALKS, STEPS, PATIOS, OR OTHER FINISH SURFACES DO NOT OCCUR.	REVISIONS ISSUE DESCRIPTION DATE	
4. U. L. APPROVED SPARK ARRESTORS W/ METAL SHROUD AT TOPS OF ALL FIREPLACE CHIMNEYS. USE IN ACCORDANCE WITH U.L. APPROVED METALBESTOS #SSII FLUE SYSTEM BY SELKIRK, ALL CHIMNEYS SHALL. TERMINATE NOT LESS THAN 2"-0" ABOVE THE HIGHEST POINT OF ROOF WITH IN 10"-0" OF CHIMNEY.		
	ARCHITECT AND APPLICANT LAUREN ADAMS, AIA BSIS WASHINTON BLVD. CULVER CITY, CA 90232 232/275-1140 XIII LAUREN & LETTERFOUR.COM	
	DISCLAIMER These plans and incorporated designs embodied thereon are the property of LETTER FOUR, LLC. The use of these plans are restricted to the original site for which they were prepared. Publication and reproduction by any method, in whole or in part, is prohibited. This to the plans and designs remain with LETTER FOUR, LLC. Visual contact with them constitutes prima facie of acceptance of these restrictions.	
	PROJECT NAME LINSCOTT DATE 06.02.14 SCALE 1/4" = 1'-0" DRAWN LA/MH JOB# 1328.00 DRAWING NAME PROPOSED EXTERIOR ELEVATIONS A-6.5	

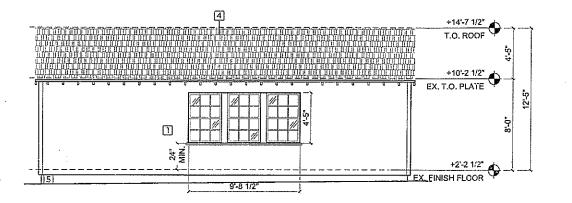

SCALE: 1/4"=1'-0" SECOND UNIT SOUTH ELEVATION O2

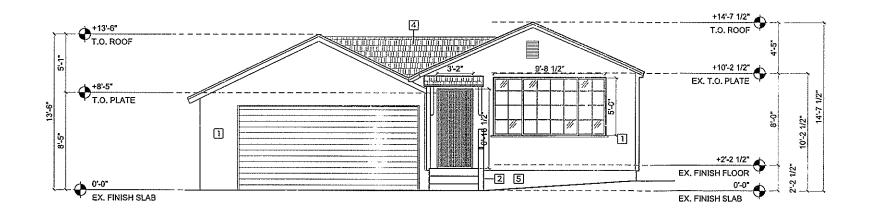


NOTES TO SHEET ARCHITECT □ ѕтиссо 2 PAINT GRADE WOOD 3 BRICK 4 CLASS "A" ASPHALT ROOFING S CONCRETE SLAB/STEM WALL 6 WOOD SIDING 7 CEMENT FIBER BOARD LETTER FOUR, LLC 8513 WASHINGTON 8LVD. CULVER CITY, CA 90232 F: 323/275-1141 INFO@LETTERFOUR.COM **8** EXISTING ALUMINUM SIDING TO BE REMOVED 9 ____ PROJECT 10 ___ LINSCOTT 1673 NEW YORK DR. (MAIN) 1917 SINALOA AVE. (2ND UNIT) ALTADENA, CA 91001 GENERAL ELEVATION NOTES APN 5847-028-026 APN 5847-028-024 1. CONTRACTOR TO VERIFY CONFORMANCE TO CITY AGENCY BUILDING HEIGHTS AND ENVELOPE LIMITS. INFORM ARCHITECT OF ANY DISCREPANCIES. LINTCOTT 110 S. GREENWOOD AVE. 2. CONTRACTOR TO COORDINATE W/ LANDSCAPE DRAWINGS FOR EXACT LOCATIONS AND ELEVATIONS OF HARDSCAPE.
INFORM ARCHITECT OF ANY DISCREPANCIES. PASADENA, CA 91107 3. PROVIDE CONTINUOUS SHEET METAL WEEP SCREED. LOCATE WEEP SCREED AT LOWEST POSSIBLE POINT OF CONCRETE FOOTING AND SILL PLATE, COLOR COAT FACE REVISIONS OF CONCRETE BELOW WEEP SCREED TO A POINT NOT LESS THAN 4" BELOW FINISH GRADE WHERE WALKS, STEPS, PATIOS, OR OTHER FINISH SURFACES DO NOT ISSUE DESCRIPTION DATE 4. U. L. APPROVED SPARK ARRESTORS W/ METAL SHROUD AT TOPS OF ALL FIREPLACE CHIMNEYS. USE IN ACCORDANCE WITH U.L. APPROVED METALBESTOS #SSII FLUE SYSTEM BY SELKIRK, ALL CHIMNEYS SHALL TERMINATE NOT LESS THAN 2'-0" ABOVE THE HIGHEST POINT OF ROOF WITH IN 10'-0" OF CHIMNEY. ARCHITECT AND APPLICANT LAUREN ADAMS, AIA 8513 WASHINTON BLVD, CULVER CITY, CA 90232 323/275-1140 X111 LAUREN@LETTERFOUR,COM These plans and incorporated designs embodied thereon are the property of LETTER FOUR, L.C. The use of these plans are restricted to the original site for which they were prepared. Publication and reproduction by any method, in whole or in part, is prohibited. Title to the plans and designs remain with LETTER FOUR, LLC. Visual contact with them constitutes prima facie of acceptance of these restrictions. PROJECT NAME LINSCOTT DATE 06.02.14 SCALE 1/4" = 1'-0" DRAWN LA/MH JOB# 1328.00 DRAWING NAME SECOND UNIT EXTERIOR ELEVATIONS


A-6.6

SECOND UNIT WEST ELEVATION O1

SCALE: 1/4"=1'-0"

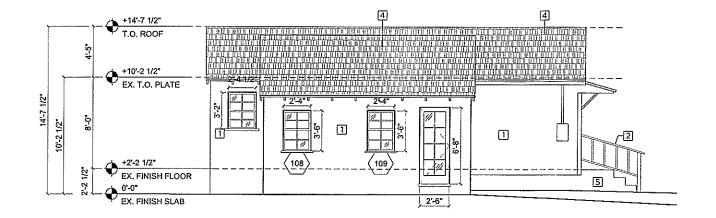

SCALE: 1/4"=1'-0" SECOND UNIT NORTH ELEVATION O2

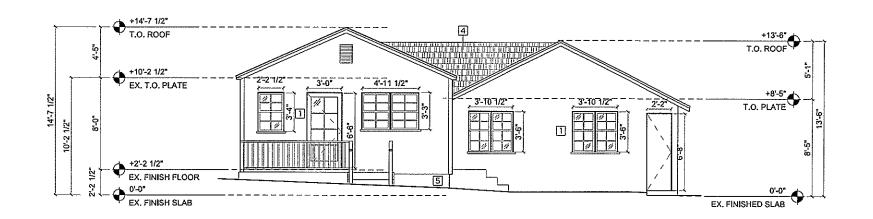

NOTES TO SHEET ARCHITECT stucco 2 PAINT GRADE WOOD 3 BRICK 4 CLASS "A" ASPHALT ROOFING 5 CONCRETE SLAB/STEM WALL 6 WOOD SIDING 7 CEMENT FIBER BOARD B EXISTING ALUMINUM SIDING TO BE REMOVED 9 ____ PROJECT 10 ___ LINSCOTT 1673 NEW YORK DR. (MAIN) 1917 SINALOA AVE. (2ND UNIT) ALTADENA, CA 91001 **GENERAL ELEVATION NOTES** APN 5847-028-026 APN 5847-028-024 CONTRACTOR TO VERIFY CONFORMANCE TO CITY AGENCY BUILDING HEIGHTS AND ENVELOPE LIMITS. INFORM OWNER ARCHITECT OF ANY DISCREPANCIES. LINSCOTT 2. CONTRACTOR TO COORDINATE W/ LANDSCAPE DRAWINGS 110 S. GREENWOOD AVE. FOR EXACT LOCATIONS AND ELEVATIONS OF HARDSCAPE. PASADENA, CA 91107 INFORM ARCHITECT OF ANY DISCREPANCIES. 3. PROVIDE CONTINUOUS SHEET METAL WEEP SCREED, LOCATE WEEP SCREED AT LOWEST POSSIBLE POINT OF CONCRETE FOOTING AND SILL PLATE, COLOR COAT FACE REVISIONS OF CONCRETE BELOW WEEP SCREED TO A POINT NOT LESS THAN 4" BELOW FINISH GRADE WHERE WALKS, STEPS, PATIOS, OR OTHER FINISH SURFACES DO NOT ISSUE DESCRIPTION DATE 4. U. L. APPROVED SPARK ARRESTORS W/ METAL SHROUD AT TOPS OF ALL FIREPLACE CHIMNEYS. USE IN ACCORDANCE WITH U.L. APPROVED METALBESTOS #SS11 FLUE SYSTEM BY SELKIRK, ALL CHIMNEYS SHALL TERMINATE NOT LESS THAN 2'-0" ABOVE THE HIGHEST POINT OF ROOF WITH IN 10'-0" OF CHIMNEY. ARCHITECT AND APPLICANT LAUREN ADAMS, AIA 8513 WASHINTON BLVD. CULVER CITY, CA 90232 323/275-1140 X111 LAUREN@LETTERFOUR.COM These plans and incorporated designs embodied thereon are the property of LETTER FOUR, LLC. The use of these plans are restricted to the original site for which they were prepared.

Publication and reproduction by any method, in whole or in part, is prohibited. Title to the plans and designs remain with LETTER FOUR, LLC. Visual contact with them constitutes prima facie of acceptance of these restrictions. PROJECT NAME LINSCOTT DATE 06.02.14 1/4" = 1'-0" LA/MH 1328.00 SECOND UNIT EXTERIOR ELEVATIONS

A-6.7

SECOND UNIT EAST ELEVATION **O1**

SCALE: 1/4"=1'-0"